

State of Hawaii
DEPARTMENT OF LAND AND NATURAL RESOURCES
ENGINEERING DIVISION
1151 Punchbowl Street, Room 221
Honolulu, Hawaii 96813

ADDENDUM NO. 2

TO

Job No. F70C616H
Sand Island State Recreation Area Improvements, Ph. VI
Honolulu, Oahu, Hawaii

May 12, 2026

This addendum as issued shall become part of the Contract Documents for the subject project. The bid documents, plans, and specifications shall be amended as follows:

PLANS

1. Sheet A2-101 – Revised callout regarding park bench material.

REQUEST FOR INFORMATION

1. **What type of coating is being applied on the concrete structures?**

Response: High-performance silicone elastomeric coating.

2. **Where can we place the excavated material on site?**


Response: Contractor to coordinate the location of any excavated material with DLNR State Parks staff during construction.

Engineering Division






Dina U. Lau
Acting Chief Engineer

Job No. F70C616H
Sand Island SRA Improvements, Ph. VI
Honolulu, Oahu, Hawaii

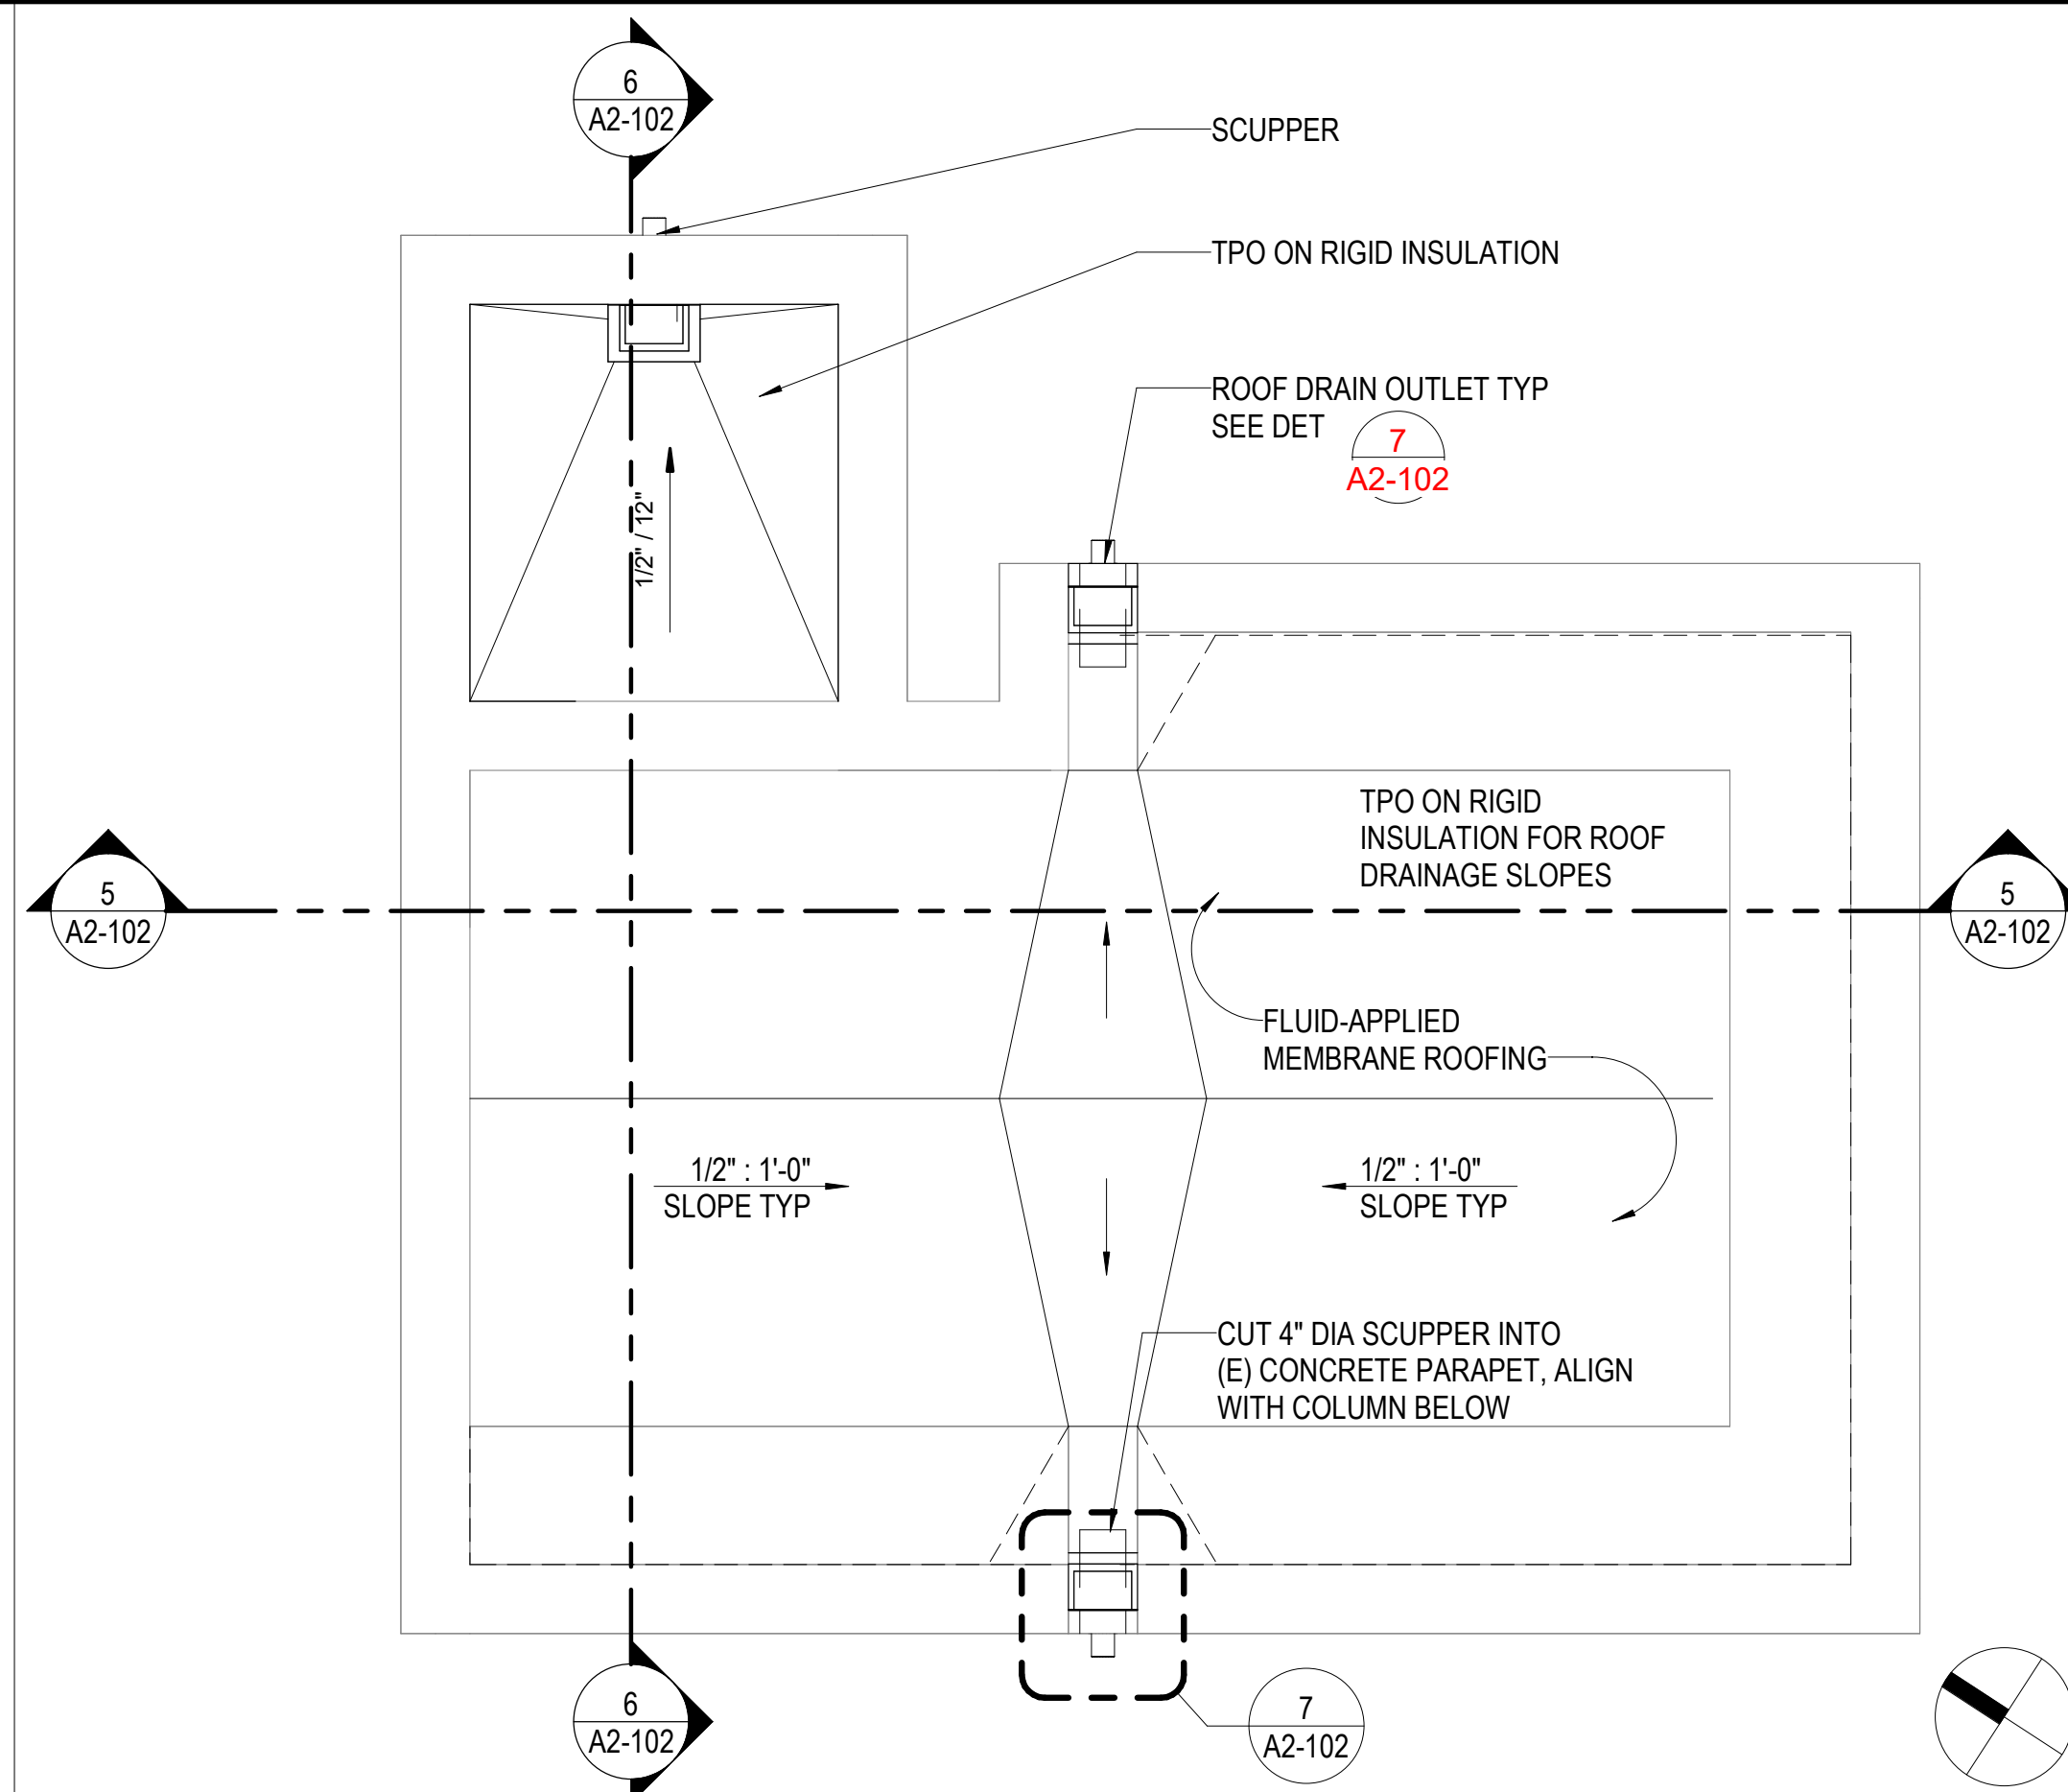


2 ANTI-AIRCRAFT ROOF PLAN
SCALE: 3/8" = 1'-0"

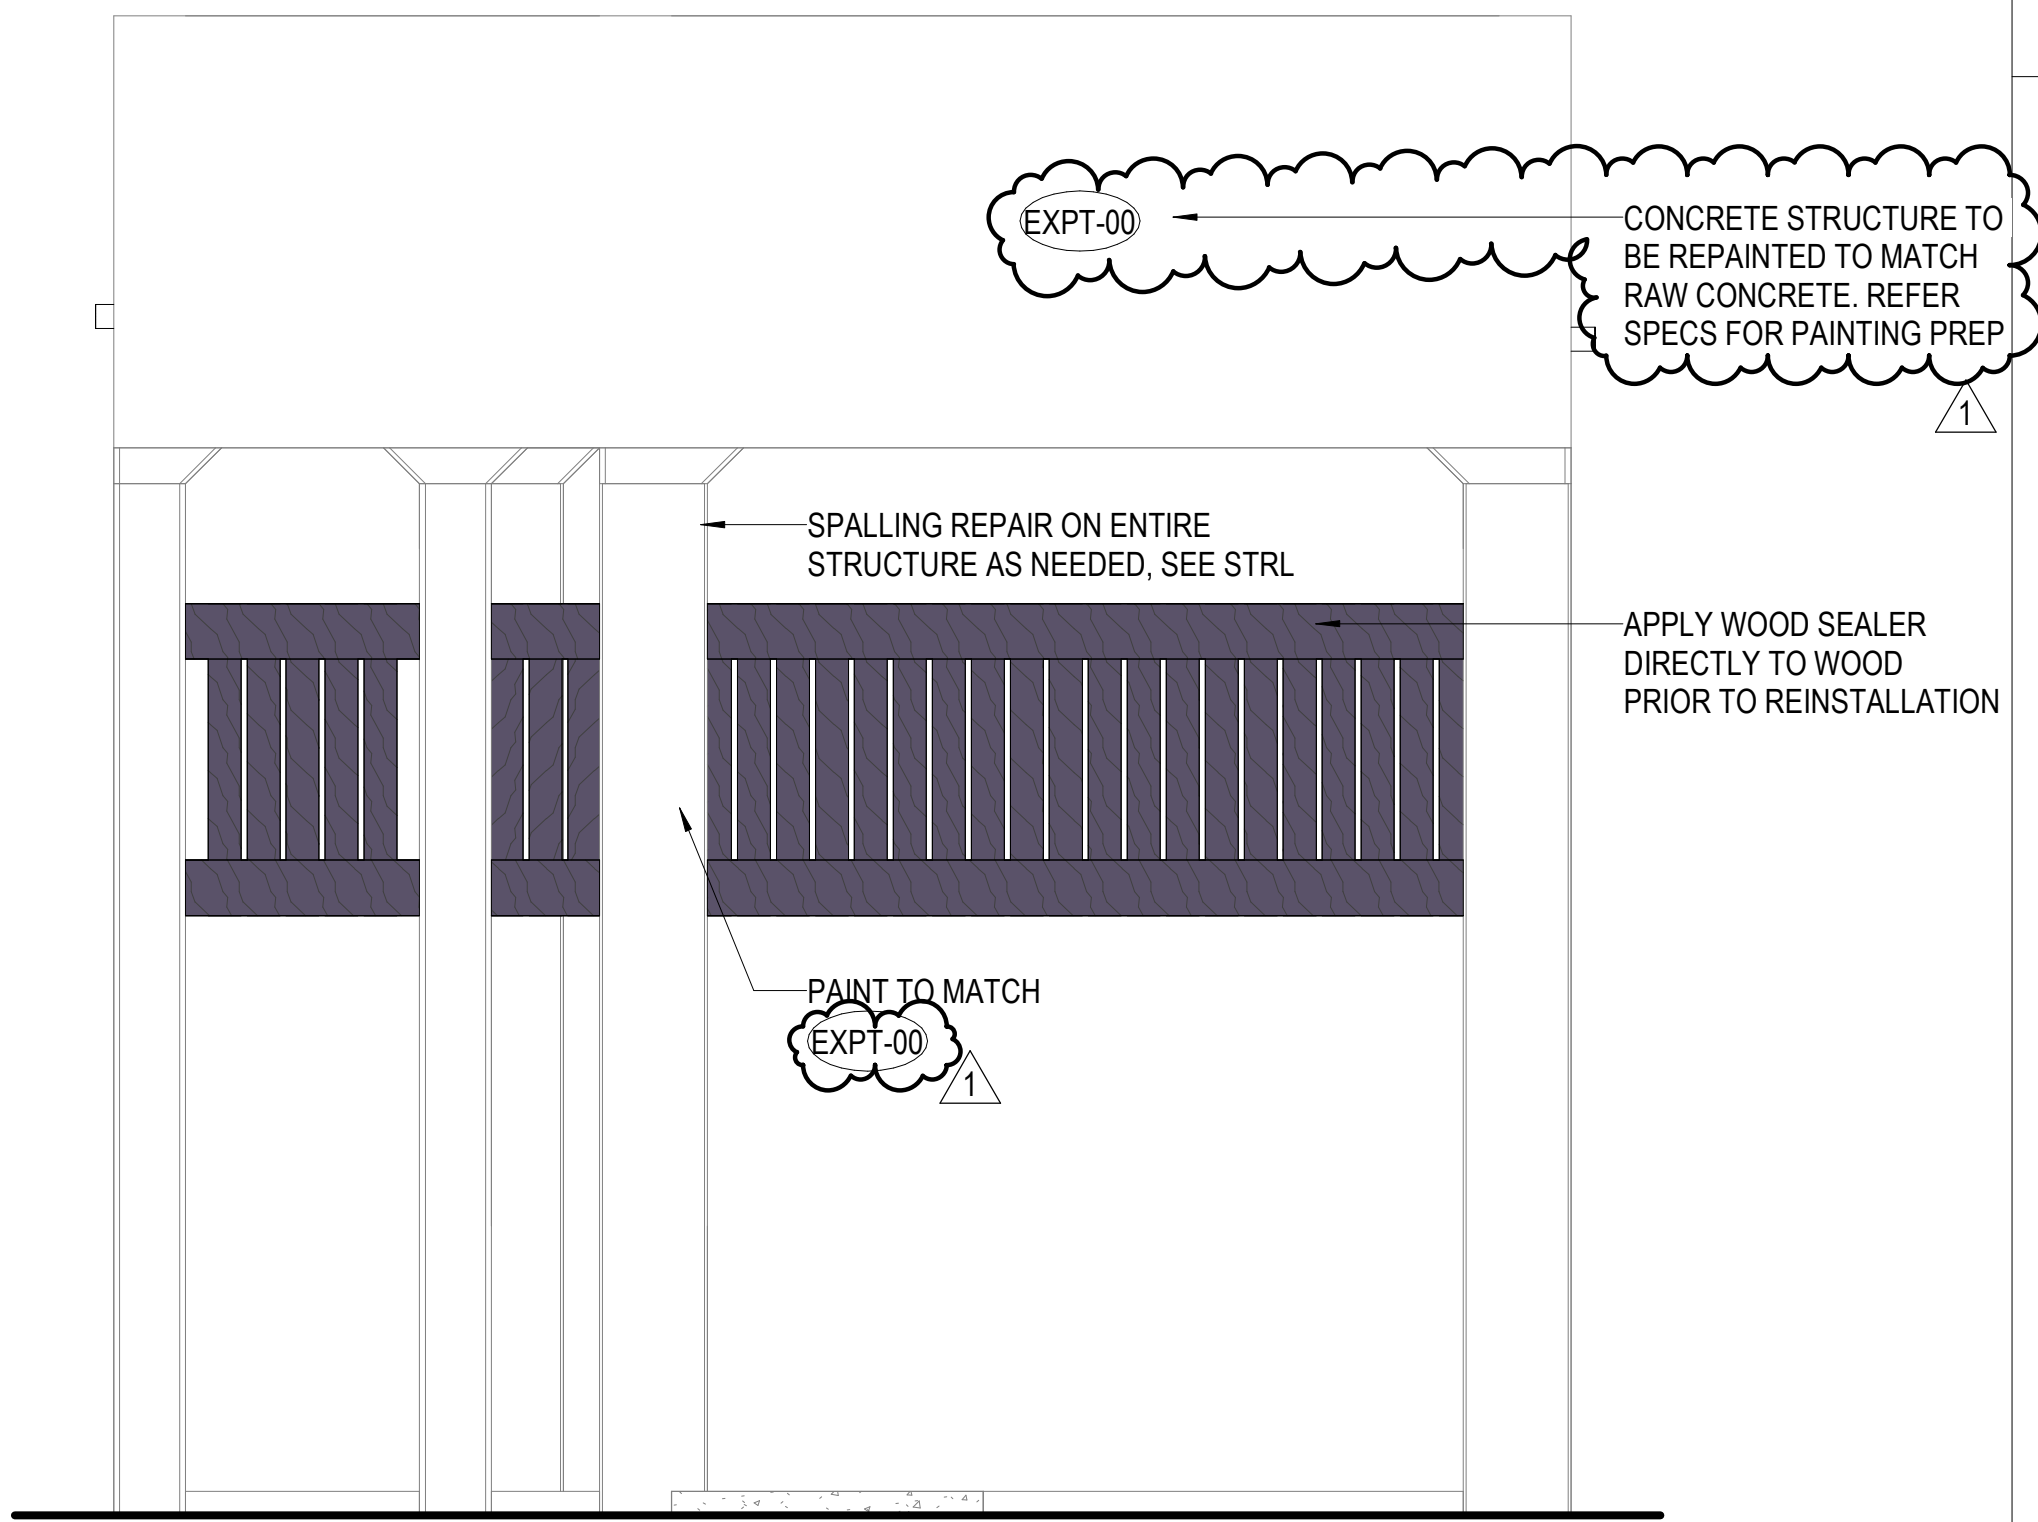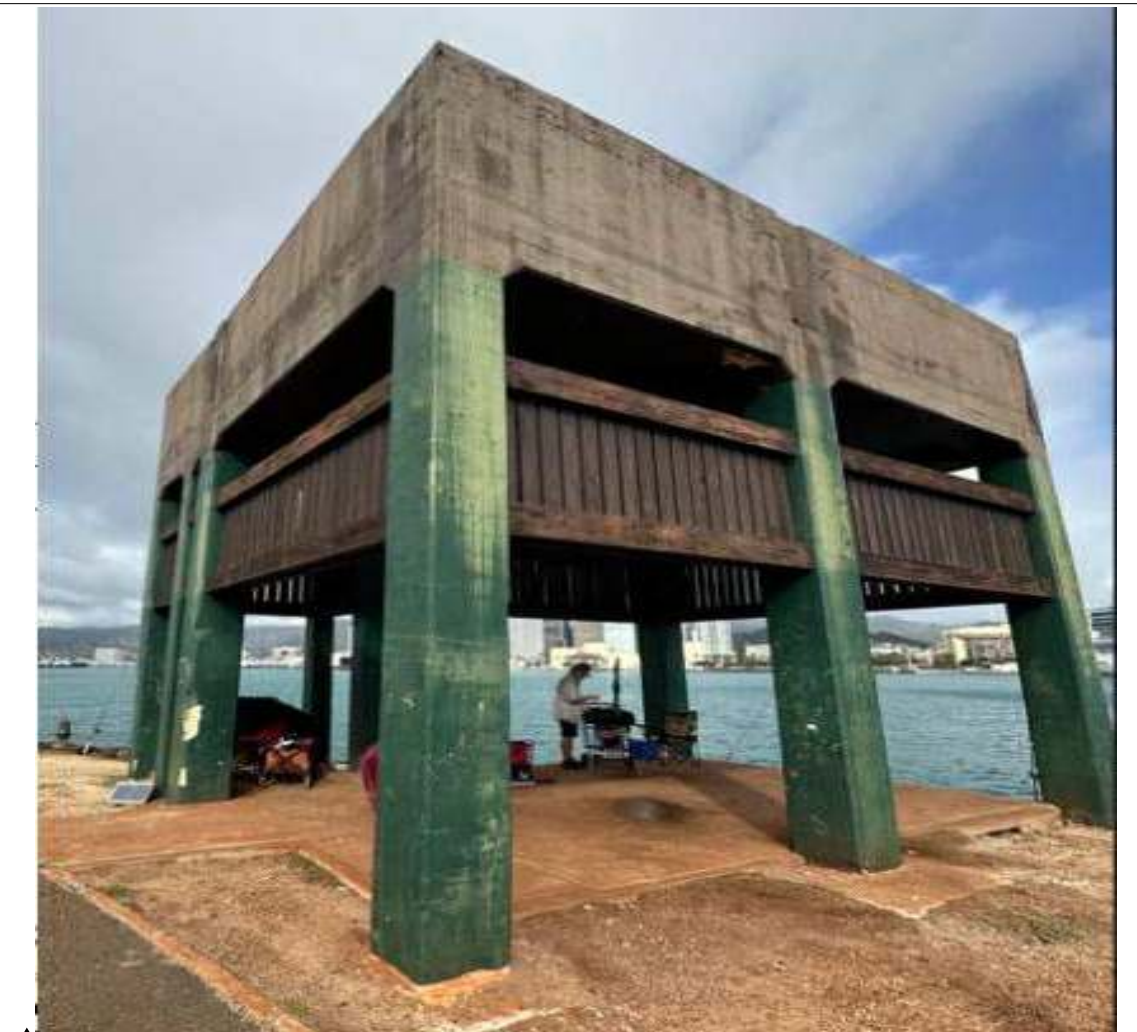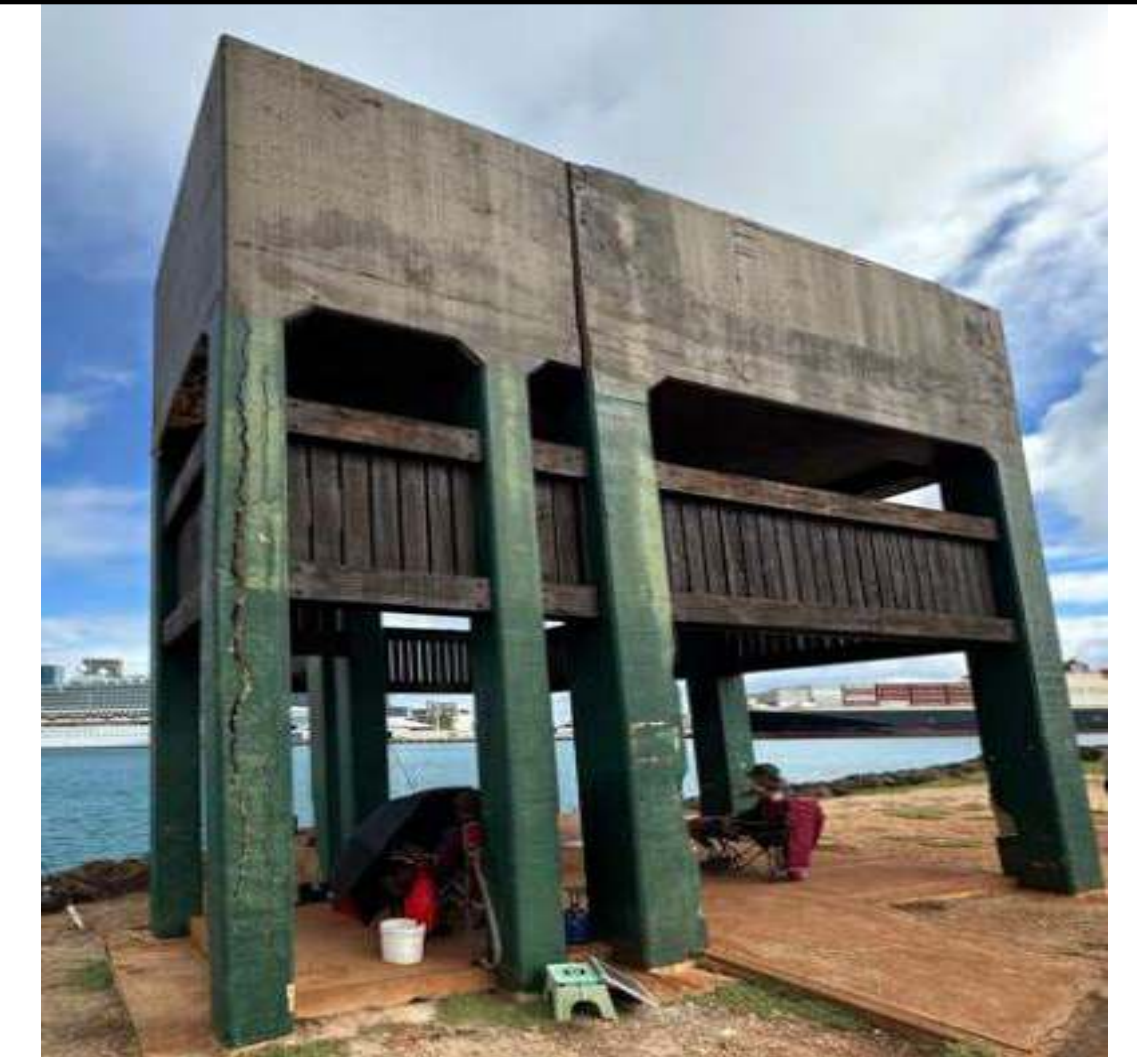

REMOVE-SALVAGE WOOD PANELS-TRELLIS & REPLACE FASTENERS AND ANCHOR BOLTS WITH SS HARDWARE MATCHING THICKNESS AND TYPE.


LEGEND:
EXPT-00 PRIME AND EGGSHELL PAINT

3 ANTI-AIRCRAFT GUN EMPLACEMENT TOWER TYPICAL SITE ELEVATION
SCALE: 3/8" = 1'-0"

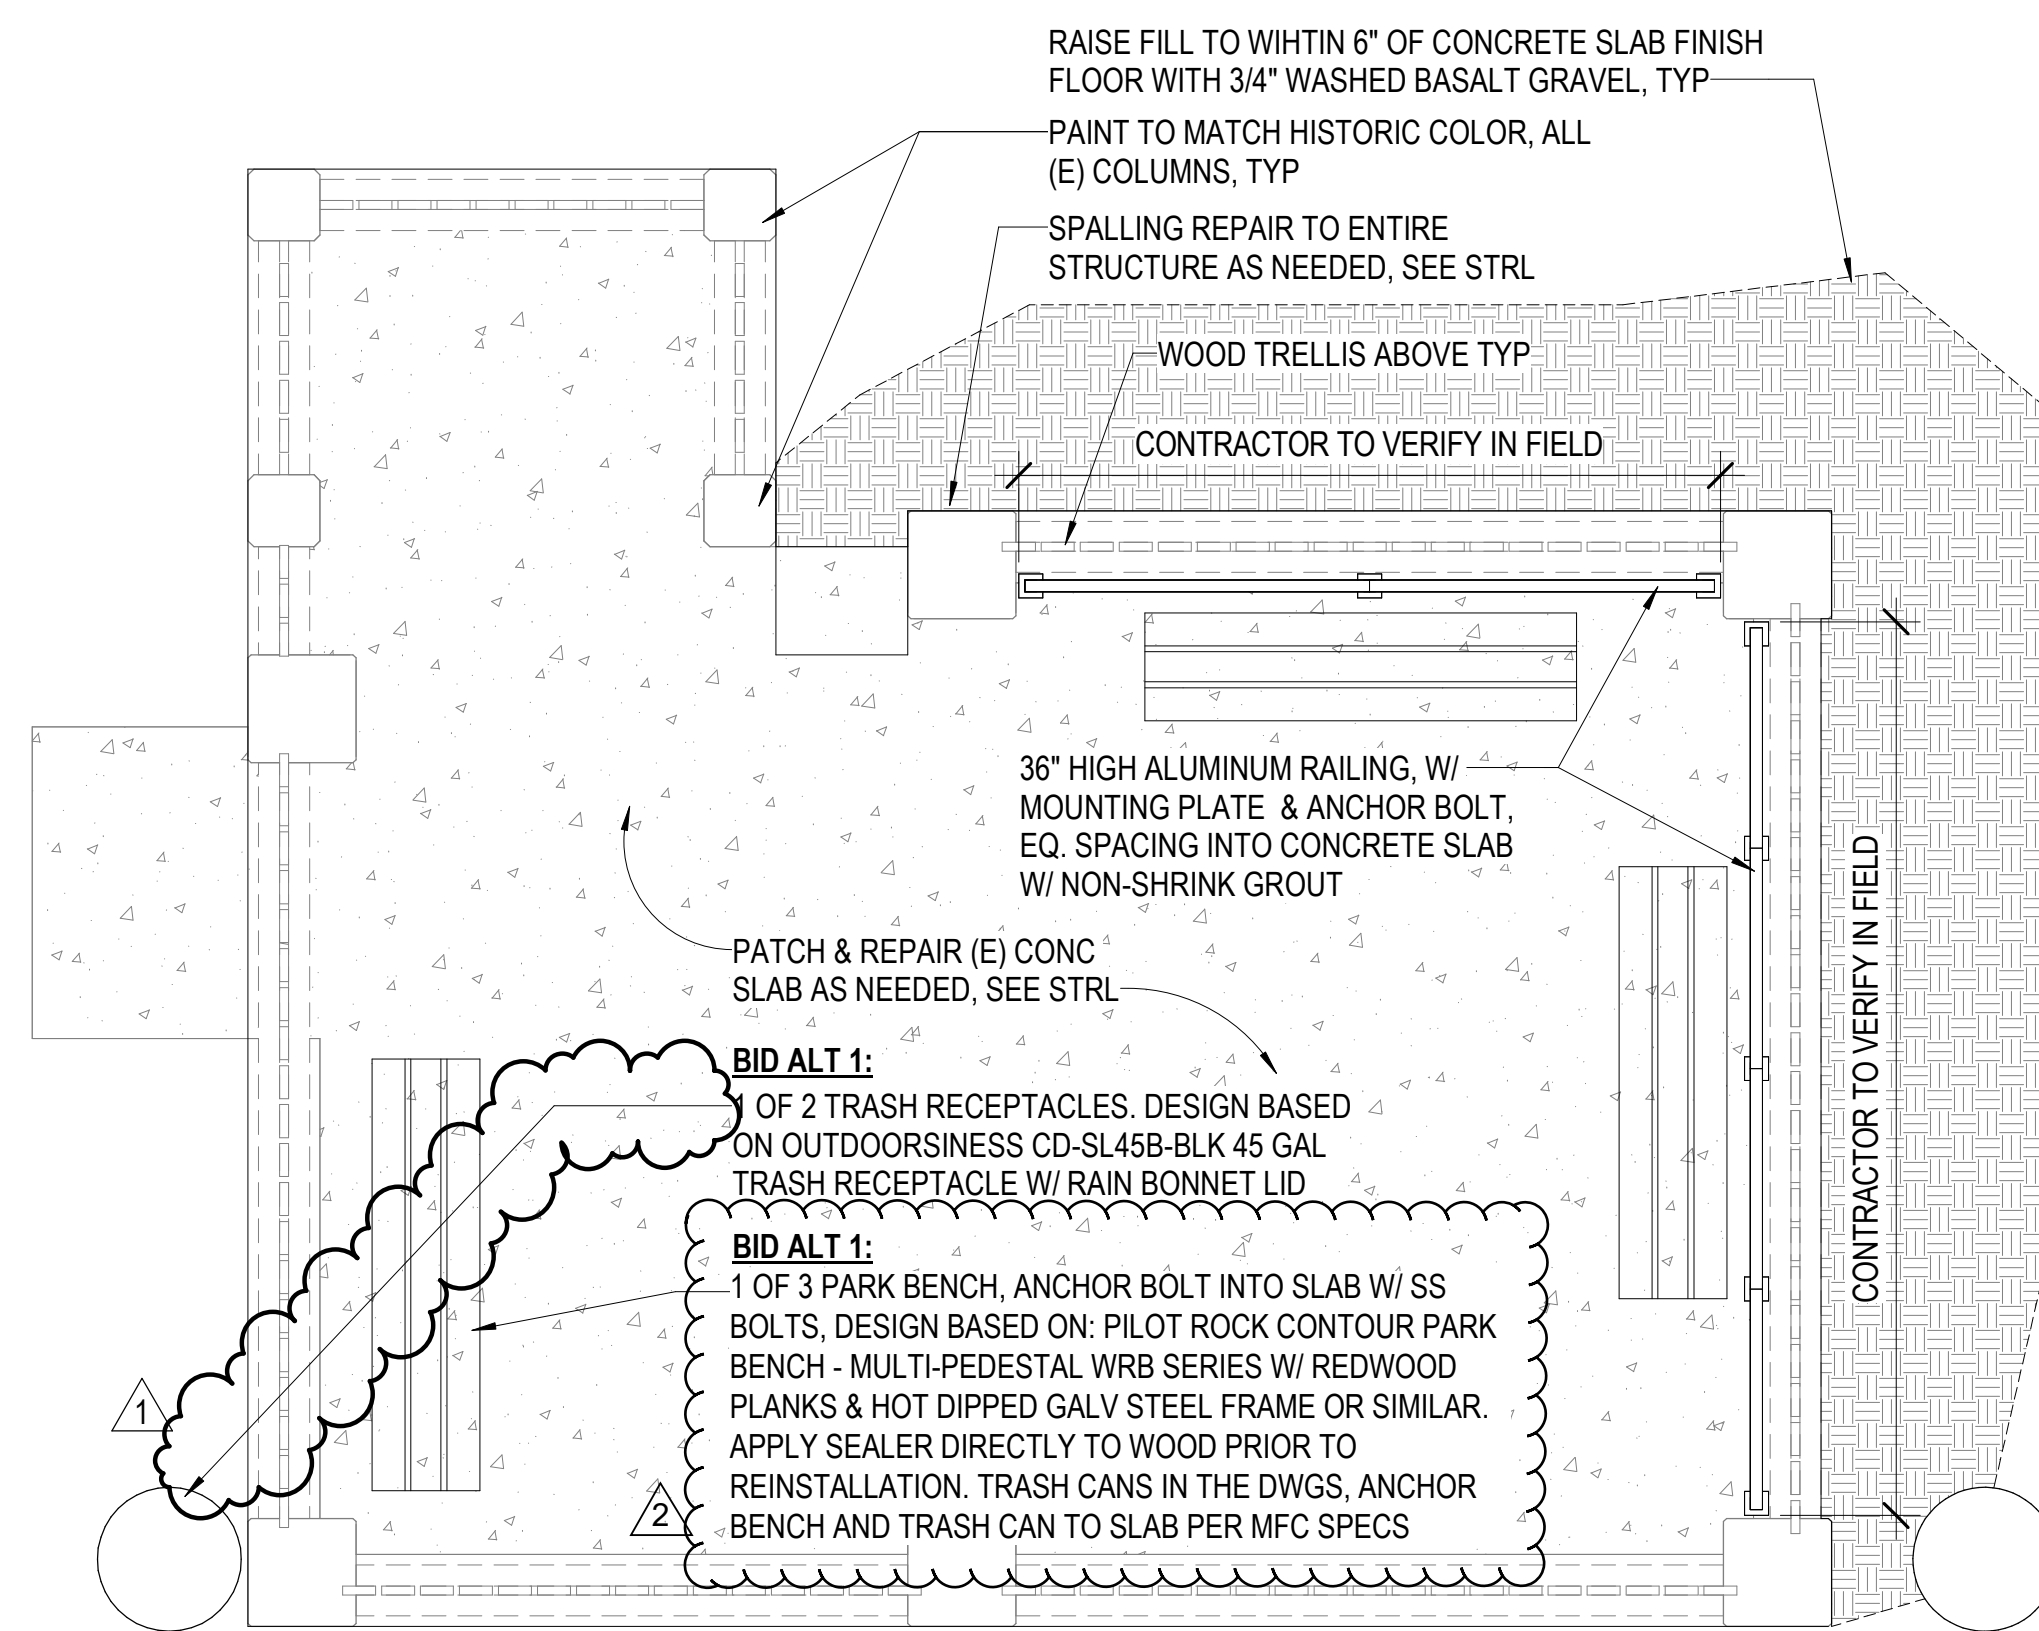

1 ANTI-AIRCRAFT GUN EMPLACEMENT TOWER FLOOR PLAN BID ALT 1
SCALE: 3/8" = 1'-0"

2	2	Addendum No. 2	05/11/2026		
1	1	Addendum No. 1	04/30/2026		
REVISION NO	SYM	DESCRIPTION	SHT OF	DATE	APPROVED:
			10 OF 29		

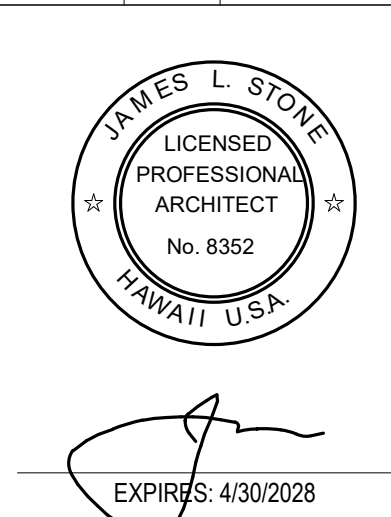

STATE OF HAWAII
DEPARTMENT OF LAND AND NATURAL RESOURCES
ENGINEERING DIVISION
SAND ISLAND SRA PARK IMPROVEMENTS PH. VI
TAX MAP KEY: 1-5-041:006
ANTI-AIRCRAFT GUN EMPLACEMENT TOWER PLANS AND ELEVATIONS

DESIGNED: JS
DRAWN: G70
CHECKED: KC
APPROVED: D

SUBMITTED: BID SUBMITTAL
DATE: 04/13/2026

Gayson Ching
E-signed 2026-05-12 08:22AM HST
gayson.y.ching@hawaii.gov
State of Hawaii
CHIEF ENGINEER

A2-101